

December 23, 2025 Newberry County Purchasing Department

ADDENDA TWO Invitation for Bids No.: 2025-18 Newberry County Museum Roof Renovations


The following shall become part of the original solicitation:

- 1. Additional Structural Drawings included.
- 2. Which style tile is preferred 12 ¼" length or 18 3/8" length, any color preferred?

 The intent is to match the existing tile as close as possible. The City of Newberry Architectural Review Board (ARB) will need to make final determination on the style, color, etc.
- 3. Will there be a line item on the bid form for wood decking replacement?

 Bid form is included and revised to reflect the line item for wood replacement; price per square foot. Additionally, an allowance of \$5,000 shall be included in the base bid for wood decking replacement.
- 4. What is the workmanship warranty requirement, if any?

 The application should be licensed by the roofing manufacturer and shall have installed an application for this roofing system on a minimum of three projects within the past three years. The applicator shall furnish a warranty covering watertightness of the roofing system for the period of three years.

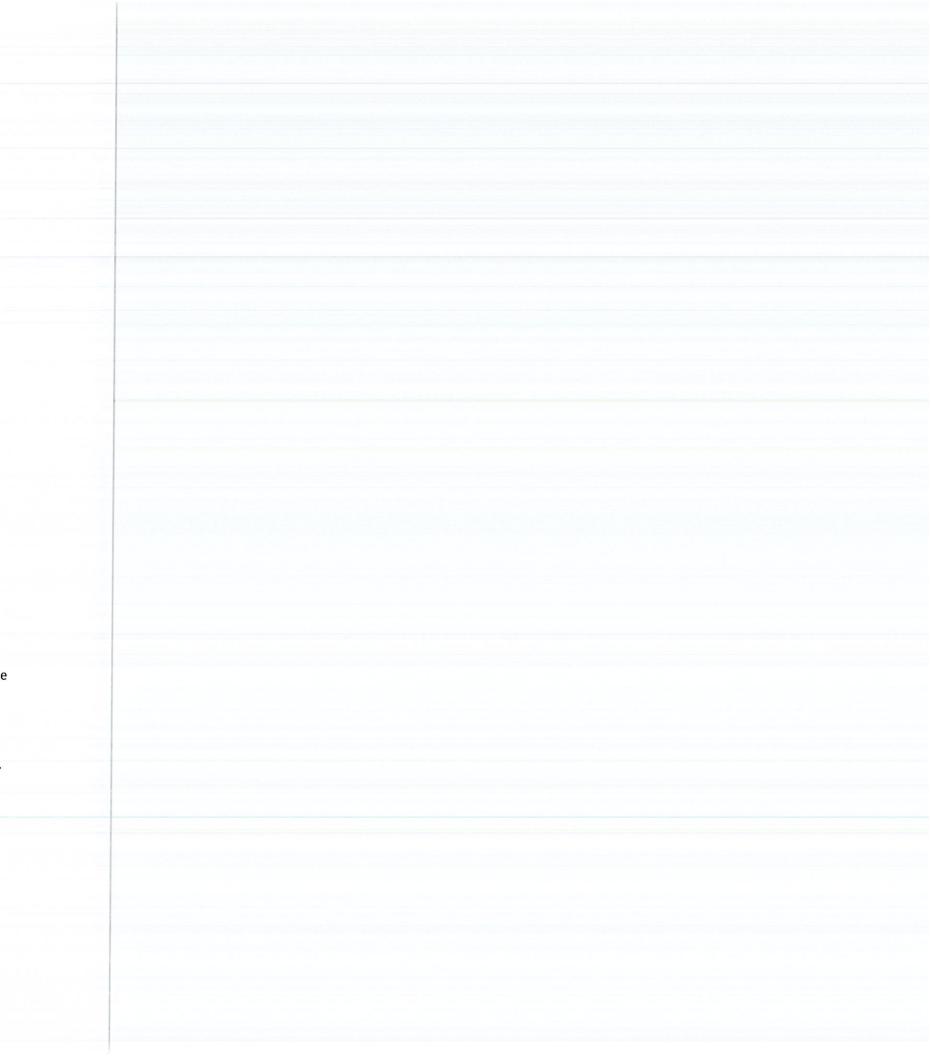

COUNTY OF NEWBERRY

Purchasing Office, 1309 College Street, Post Office Box 156, Newberry S.C. 29108 Ph: (803) 321-2100 / Fax: (803) 321-2102

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ce Room					
Newberry Museum Roof Repairs					

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GENERAL NOTES: THESE GENERAL NOTES PRESENT AND/OR SUMMARIZE KEY PROJECT INFORMATION. SEE PLANS FOR FURTHER REQUIREMENTS. . ALL REFERENCES TO STANDARDS HEREIN ARE TO MOST RECENT ISSUE IN EFFECT AS OF THE DATE OF THESE DOCUMENTS, UNLESS NOTED OTHERWISE. DESIGN BASIS: 2021 INTERNATIONAL BUILDING CODE (IBC) WITH SC AMENDMENTS A. GENERAL RISK CATEGORY = II B. WIND: ILLTIMATE DESIGN WIND SPEED = 111 MPH WIND EXPOSURE CATEGORY = C INTERNAL PRESSURE COEFFICIENT = 0.18 ± (ENCLOSED BUILDING) COMPONENT & CLADDING DESIGN PRESSURE - SEE DIAGRAMS C. SEISMIC: SEISMIC IMPORTANCE FACTOR In = 1.0 MAPPED SPECTRAL RESPONSE ACCEL (SHORT PERIODS) 58 = 0.324 IAAPPED SPECTRAL RESPONSE ACCEL (1 SECOND PERIOD) 51 = 0.102 SITE CLASS = 0 SPECTRAL RESPONSE COEFFICIENT (SHORT PERIODS) SDS = 0.333 SPECTRAL RESPONSE COEFFICIENT (1 SECOND PERIOD) 501 = 0.163 SEISMIC DESIGN CATEGORY = 0 ROOF: 20 psf E. SNOW LOAD GROUND: 10 psf 4. ABBREVATIONS: AB ANCHOR BOLT EXT EXTERIOR PL.S. PLACES BUSHING MARKET PLOOR PLOS PLACES BUSHING MARKET PLOOR PLOS PLACES BUSHING MARKET PLOOR PLOS PLACES BUSHING PLOOR PLOS PLACES BUSHING PLOOR PLOS PLACES BUSHING PLOOR PLOS PLACES BUSHING PLOOR PLOOR REINF REINFORCING BUSHING PLOOR PLOOR REINF REINFORCING BUSHING PLOOR PLOO

- COORDINATE WORK OF OTHER TRADES SHOWN ON DRAWINGS OR WITH STRUCTURAL WORK.
- 7. SHOP DRAWINGS FOR ANY PART OF THE STRUCTURAL WORK SHALL SHOW THE INTERFACE WITH OTHER RELATED TRADES. THE CONTRACTOR SHALL VERIFY DIMENSIONS, LOCATIONS, MATERIALS ETC. OF RELATED TRADES BY CERTIFIED MANUFACTURER'S DRAWINGS AND SO INDICATE BEFORE SUBMITTING SHOP DRAWINGS FOR ARCHITECT/ENGINEERS APPROVAL.
- THE DESIGN OF THE STRUCTURE SHOWN IS BASED ON INTERACTION OF VARIOUS CONNECTED PARTS AND THE DESIGN LOADS NOTED ABOVE. THE STREINGTH AND STABILITY OF CONSTRUCTION UNDERWAY MAY REQUIRE SUPPLEMENTAL TEMPORARY SUPPORTS, BRACKING OR OTHER MEASURES. THE CONTRACTOR SHALL OETERMINE THE NEED OF SUCH TEMPORARY SUPPORT DURING CONSTRUCTION AND PROVIDE ALL SUCH MEASURES.

- ALL WOOD FRAMING SHALL BE DESIGNED AND ERECTED IN ACCORDANCE WITH THE RECOMMENDATIONS OF THE LATEST EDITION OF THE NATIONAL DESIGN SPECIFICATION (NDS) FOR WOOD CONSTRUCTION MANUALS.
- 2. UNLESS NOTED OTHERWISE, ALL FRAMING SHALL BE #2 SOUTHERN PINE OR BETTER.
- NO MEMBER STRESS INCREASES DUE TO LOAD DURATION ARE ALLOWED, LE, DURATION FACTOR EQUALS 1.0.
- ALL FRAMING, SILL PLATES, TOP PLATES, BRIDGING, BRACING AND ACCESSORIES SHALL MEET THE REQUIREMENT OF THE IBC CODE. AS A MINIMUM 164 FRAMING NAILS SHALL BE USED. UNLESS NOTED OTHERWISE ALL NAIL SIZES AND NAILING PATTERNS SHALL MEET THE REQUIREMENTS OF THE IBC 2019.
- 5. PROVIDE PERMANENT 2X4 LATERAL BRIDGING (#2 SOUTHERN PINE OR BETTER) BETWEEN EACH FLOOR JOIST OR ROOF RAFTER. BRIDGING IS TO BE SPACED AT NO MORE THAN 8"-0" O.C.
- 6. VOIDS BENEATH BOTTOM PLATE SHALL NOT BE PERMITTED. CONTRACTOR SHALL PROVIDE A REASONABLY LEVEL SLAB WITH A TOLERANCE OF 1/8" IN 10 FEET. WHERE UNEVENNESS OF SUPPORTING FLOOR PREVENTS CONTINUOUS SOLID BEARING, PLATE SHALL BE LEVELED BY PLACING MORTAR OR GROUT BENEATH TRACK.
- 7. ALL WOOD MEMBERS ABOVE THE PLANE OF ROOF SHALL BE PRESSURE TREATED.
- EXTERIOR WALL SHEATHING SHALL BE FASTENED TO ROOF RAFTERS w/10D NAILS @ 4" O.C. MAXIMUM ON EDGE OF SHEATHING & 6" O.C. OTHER MEMBERS.
- 9. WOOD FRAMING SHALL NOT BE NOTCHED FOR UTILITIES.
- TOP PLATES OF EXTERIOR WALLS & INTERIOR SHEAR WALLS SHALL BE REINFORCED WHERE NOTCHED WISIMPSON CTS COMPRESSION & TENSION STRAPS.

- 11. PLYWOOD AND GRIENTED STRAND BOARD (OSB)

 A. STAGGER END JOINTS OF ROOF SHEATHING AND SHEAR WALLS

 B. H-CLIPS SHALL BE USED FOR ALL ROOF SHEATHING
- 12. STAGGER END JOINTS OF ADJACENT COURSES OF GYPSUM WALL BOARD USED AS SHEAR WALL SHEATHING. END JOINTS SHALL NOT OCCUR OVER THE SAME VERTICAL STUD.
- 3. ALL ENGINEERED LUMBER SHALL HAVE THE FOLLOWING MINIMUM MATERIAL PROPERTIES.

 A. Fb = 2800psi
 B. Fv = 285psi
 C. E = 1,900,000psi
 D. Fdl = 2510psi
 E. Fc² = 750psi
 F. G = 125,000psi


- 14. ALL METAL WOOD CONNECTIONS SHALL BE FULLY NAILED PER THE REQUIREMENTS OF SIMPSON STRONG PRODUCTS. ALL CONNECTORS SHALL BE CAPABLE OF RESISTING THE CORROSIVE EFFECTS OF THE EXTERIOR PRESERVATIVE PRESSURE TREATMENT AND SHALL BE INSTALLED PRIOR TO APPLICATION OF LOADS.

	CTIVE A (SQ FT)	ASCE 7-16, CHAPTER 30 / BWS 111 / SLOPES 27-45 DEGREES						
ROOF	WALLS	0	(2e)	(<u>2</u>)	3	•	(5)	
< 10	< 10	+23.3 -37.2	+23.3 -44.6	+23.3 -42.4	+23.3 -50.2	+31.3 -34	+31.3 -4	
20	20	+20.1 -32.8	+20.1 -39.5	+20.1 -39.1	+20.1 -42	+29.9 -32.6	+29.9 -39.	
50	50	+15.9 -27	+15.9 -32.9	+15.9 -34.7	+15.9 -31.3	+28.1 -30.7	+28.1 -35.	
> 100	> 100	+12.7 -22.6	+12.7 -27.8	+12.7 -31.4	+12.7 -31.3	+26.5 -29.3	+26.6 -32.	

COMPONENTS & OL ASSUITA

NOTES:

- 1 a = 5'-0"
- POSITIVE PRESSURE VALUES REFER TO FORCES ACTING TOWARDS BUILDING, NEGATIVE PRESSURE VALUES REFER TO FORCES ACTING AWAY FROM BUILDING.
- EACH COMPONENT MUST BE DESIGNED FOR MAXIMUM POSITIVE AND NEGATIVE FORCES.
- 4. FOR COMPONENTS HAVING EFFECTIVE AREAS IN BETWEEN TABULATED VALUES, DESIGN LOADS MAY BE INTERPOLATED. OTHERWISE DESIGN LOAD MUST BE TAKEN FROM THE NEXT LOWEST EFFECTIVE AREA
- 5. THE FINAL NET DESIGN WIND PRESSURE, INCLUDING ALL PERMITTED REDUCTIONS, SHALL NOT BE LESS THAN 16 ps/ACTING IN EITHER DIRECTION.

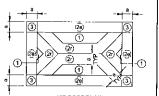



JOHNSON, LASCHOBER & ASSOCIATES, P.C.

AUGUSTA, GA • CHARLESTON, SC TEL (706) 724-5756 • TEL (843) 619-4856 FAX (706) 724-3955 WAW/THEJLAGROUP COM

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SHACKER BOX 156, NEWBER လွတ္

NEWBERRY MUSEUM RENOVATION

NOT FOR CONSTRUCTION

3606.2502 AAR EGW


S-001

AS NOTED

PROJECT NO. DRAWN BY: CHECKED BY:

10/30/2025 SHEET TITLE: **GENERAL NOTES**

SCALE

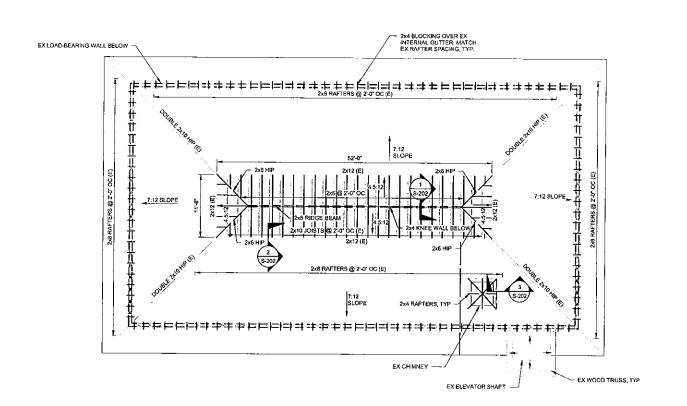

FRAMING PLAN
S-201 SCALE: 1/8" = 1"-0"

PROJECT LOCATION

VEWBERRY COUNTY P.O. BOX 156, NEWBERRY COUNTY P.O. BOX 156, NEW 156, NEW

CONSTRUCTION

PROJECT NO. 3606.2502
DRAWN BY: AAR
CHECKED BY: EGW
DATE: 10/30/2025
SHEET TITLE:

FRAMING PLAN

NEW 5/8" ROOF SHEATHING ATTACH TO FRAMING W/ 10D NAILS @ 6" OC

LEGEND:

8 18 24 F7

SCALE: 1/8" = 1"-0"

scale AS NOTED
DRAWING NO. REV

